

REPORT FOR

CONFIDENTIAL MEETING OF COUNCIL

MEETING DATE

12 DECEMBER 2023

RECORD NO:

D23/99426

REPORT OF:

STRATEGY & FINANCE

TITLE:

TILLEY RECREATION PARK CLUBROOM CONSTRUCTION -

TENDER RECOMMENDATION

- 1. That pursuant to Section 90(2) of the Local Government Act 1999, the Council orders that the public (except staff on duty) be excluded from the meeting to enable discussion on the Tilley Recreation Park Clubroom Construction Tender Recommendation.
- 2. That the Council is satisfied that pursuant to section 90(3)(b) and (k) of the Local Government Act 1999, the information to be received, discussed or considered in relation to this item is:
 - information the disclosure of which could reasonably be expected to confer a commercial advantage on a person with whom the council is conducting, or proposing to conduct, business, or to prejudice the commercial position of the council; AND
 - information the disclosure of which would, on balance, be contrary to the public interest; AND
 - tenders for the supply of goods, the provision of services or the carrying out of works;
 on the basis that the report includes details regarding commercial negotiations and tender evaluations, which could compromise effective negotiation for achieving the best outcome for Council and the community.
- 3. In addition, the disclosure of this information would, on balance, be contrary to the public interest. The public interest in the public access to the meeting has been balanced against the public interest in the continued non-disclosure of the information. The benefit to the public at large resulting from withholding the information outweighs the benefit to it of disclosure of the information. The Council is satisfied that the principle that the meeting be conducted in a place open to the public has been outweighed in the circumstances on the basis that early release of this information could compromise effective negotiation for achieving the best outcome for Council and the community.

PURPOSE

To consider the awarding of a Lump Sum contract for the Tilley Recreation Park Clubroom Construction noting that the award is required to occur prior to the end of this calendar year to allow for the pricing to be maintained and for construction to commence early in the new year.

RECOMMENDATION

That Council having considered the report titled "Tilley Recreation Park Clubroom Construction – Tender Recommendation" dated 12 December 2023:

- 1. Approves the award of the Tilley Recreation Park Clubroom Construction to Sarah Constructions, subject to final negotiations and clarifications, for a value of no more than \$5,761,367
- 2. Approves the allocation of an additional \$545K from interest earnt and saved funds which have been previously, and will continue to be, transferred in budget reviews to the building future fund capital works budget line as detailed in Table 1 of Section 3 of this report.

RETENTION OF CONFIDENTIAL DOCUMENTS

- 1. That having considered the agenda item titled "Tilley Recreation Park Clubroom Construction Tender Recommendation" and dated 12 December 2023 in confidence under section 90(2) & (3) b (i), b (ii) and k and Section 91(7) of the Local Government Act 1999:
 - information the disclosure of which could reasonably be expected to confer a commercial advantage on a person with whom the council is conducting, or proposing to conduct, business, or to prejudice the commercial position of the council; AND
 - information the disclosure of which would, on balance, be contrary to the public interest; AND
 - tenders for the supply of goods, the provision of services or the carrying out of works

the Council pursuant to section 91(7) of the Act orders that the report, attachments and minutes relevant to this item be retained in confidence until once the tender has been awarded and contract signed. or until the Council resolves otherwise, whichever occurs first.

2. That Council gives the power pursuant to Section 91 of the Local Government Act 1999 to the Chief Executive Officer to revoke the order made under Section 91 (7) of the Local Government Act 1999 subject to the Chief Executive Officer consulting with the Mayor and reporting to the Elected Members of the revocation.

1. BACKGROUND

The Tilley Recreation Park Clubroom is the first phase of the Tilley Recreation Park Masterplan Project, involving the construction of a two-story clubroom and changeroom building adjacent to the existing soccer pitches, and some improvements to car parking and vehicle access arrangements. Upon completion, the new building will be leased to the Tea Tree Gully City Soccer Club (TTGCSC).

On 14 November 2023 Council endorsed a recommendation to delegate to the CEO to award the tender to another contractor, however that contractor has since withdrawn their tender submission sighting a change in available capacity to deliver the project successfully.

On this basis, at their meeting on 28 November 2023, Council rescinded the above resolution.

2. DISCUSSION

The tender evaluation panel reviewed the remaining tenders. Sarah Construction was the next highest scoring tender. Their lump sum price was \$543,452 above the available construction budget of \$5,217,915.

Sarah Constructions have confirmed their capacity to deliver the project and a willingness to work together to de-scope the project if required to reduce their lump sum price.

The evaluation panel have met with Sarah Constructions, the cost consultant (Rider Levett Bucknall) and architects (Walter Brooke) to explore further options to reduce costs. A number of options were explored that included a combination of reducing the floor area and changes in some design finishes and fixings.

Option 1

This option will result in the project being delivered without significant changes to the current design which is included in Attachment 1.

Cost savings will be limited to minor cosmetic changes such as finishes and fixings.

This option will require up to an additional \$545k of funding to the total project budget which is able to funded from the building future fund, which has increased due to grant interest saved and interest earnt on the funds allocated from this project. The allocation of interest earnt is a requirement of the funding agreements. The allocation of interest saved is at Council's discretion, however is reasonable as the interest saved due to timing partially offsets the price increases based on time.

Option 2- amended scope (not recommended)

This option has been included to allow members to be aware that alternative options other than automatically increasing the budget have been considered.

This option aims to deliver the project as close as possible to the total budget identified in the Prudential Review of \$5,817,275. Attachment 2 provides an outline of the potential reductions in scope to reduce costs. Key changes include removal of the keg and storage room, reduced size of function room, removal of a cleaners' room, removal of solar panels and reduction in the width of the balcony.

Initial discussions with the club indicate the option has a number of limitations which may render part of the savings proposed in this option unviable from an optional perspective.

In addition, further or alternative reductions beyond those outlined above are not recommended as they would compromise the objectives of the project and offer diminishing returns as the cost of redesign and lost time cancel out savings.

The total savings have been estimated at approximately \$429,000. However, there would be additional consultant costs to redesign the building that have been estimated at \$75,000, taking the overall project savings to \$354,000. It is also noted that any changes to the design at this stage could delay the commencement of the project while the documentation is updated which could result in higher costs.

Overall, this option prior to price escalations will require up to an additional \$189,452 of funding to the total project budget based on current costs and is likely to incur further escalation due to time delays which are estimated to be between \$200k-\$300k which is approximately \$100k less than the current scope of works. This option is likely to also result in the project not being completed prior to the commencement of the 2025 soccer season.

On this basis this option is not recommended and option 1 is recommended as it will deliver the project as designed with the stakeholders to meet their needs for the next 50 years.

3. FINANCIAL

All figures discussed below refer to total project cost which is made up of the construction contractors lump sum, plus fees and charges, and contingency.

Funding for the project is supported by two State Government grants, with one grant specifically tied to completion of the Project (\$1.5m) and another grant tied to completion of the broader Tilley Masterplan (\$4.75m).

Council's contribution to the project is \$2.86m with a supporting \$50k contribution from the TTGCSC.

If the current project scope was to be delivered with Sarah Constructions as the preferred tenderer, up to an additional \$545k would be required to deliver the project. Staff would continue to work with the contractor and design team to identify value management strategies without significantly impacting the project scope and quality which would be reflected in the final lump sum accepted from Sarah Construction.

The additional funds required under each option presented in this report can be funded through interest earnt on the Tilley Recreation Park grant funds (currently \$363k) that will continue to accumulate until the completion of the project.

These funds must be spent on the Tilley Recreation Park project as part of the funding agreement.

In addition, Council has saved \$195k interest on this project since it was first placed in the budget.

Interest earnt has been allocated to the building future fund in the capital works budget during budget reviews in 2021,22,23 and interest saved will be allocated in future financial budget reviews.

Table 1: Forecast budget TTSC building

| | \$'000 | Comments | |
|--|--------|------------------------------|--|
| Original budget allocated to building | 5,817 | As per prudential report | |
| Interest earnt to date | 363 | Actual | |
| Interest forecast to be earnt for remain | 145 | Conservatively estimated | |
| part of project | | | |
| Interest forecast to be saved | 195 | Conservatively estimated | |
| Total available | 6,520 | | |
| Building budget | | | |
| Sarah Constructions contract award | 5,761 | | |
| Allocated contingency | 288 | | |
| Fees and other expenses | 314 | | |
| Subtotal building cost | 6,363 | | |
| Remaining funds to be allocated to | 157 | Will be added to funding of | |
| Tilley master plan budget | | \$3,733k allocated for other | |
| | | master plan works. | |

4. STRATEGIC OBJECTIVES

Strategic Plan

The following strategic objectives in Council's Strategic Plan 2025 are the most relevant to this report:

| Objective | Comments | |
|---|---|--|
| Comn | nunity | |
| People feel a sense of belonging, | The TTGSC and other groups at Tilley | |
| inclusion and connection with the City | will benefit from the new clubroom | |
| and the community | building. | |
| Ecor | nomy | |
| A local economy that is resilient and | As per Council's Procurement policy, | |
| thrives, where businesses are supported | tenderers were evaluated for their | |
| to grow and prosper, provide local jobs | impact on local businesses and | |
| and sustain our community and visitors | residents. | |
| and utilize technology to improve the | | |
| livability of our city | | |
| Pla | ces | |
| Infrastructure and community facilities | The development has been designed in | |
| are fit for purpose, constructed using | consultation with users to meet their | |
| sustainable practices and well | needs. The assets have been designed | |
| maintained | with a target 50-year life. | |
| Leadership | | |
| Planning considers current and future | The development has been designed to | |
| community needs | meet community needs for 50 years. | |
| | The tender process complied with | |
| Decision making is informed, based on | Council's Procurement Policy, which | |
| evidence and is consistent | endeavours to ensure a consistent, fair | |
| | and transparent approach. | |

Community Land Management Plans

The proposal is consistent with the relevant Community Land Management Plan for the reserve or council facility.

Policies / Strategies

The tender process complied with Council's Procurement Policy, which endeavours to ensure a consistent, fair and transparent approach.

5. LEGAL

A contract for construction will be entered into with the successful contractor and managed by Council.

6. RISK - IDENTIFICATION AND MITIGATION

Risks have been identified in a risk assessment and these have been managed through the tender process and will continue to be managed during the building works.

7. ACCESS AND INCLUSION

The design for the proposed buildings includes all Statutory Requirements & Australian Standards to meet the Disability Discrimination Act 1992.

8. SOCIAL AND COMMUNITY IMPACT

TTGCSC and other users of Tilley Recreation Park will benefit from the new clubroom building.

A project communications plan has been developed to manage the impact to users during construction.

9. ENVIRONMENTAL

The building has been designed to minimise carbon and environmental impacts where feasible.

10. ASSETS

The new assets have been designed with a 50-year asset life.

Once construction is complete, the relevant Asset Management Plans (Buildings and Open Space) will be updated to reflect the new assets constructed through the Project.

The TTGCSC will be required (under a Lease agreement) to manage the appropriate funds to maintain the new Sporting Clubroom asset and provide annual maintenance to items that are agreed upon through the lease agreement.

11. PEOPLE AND WORK PLANS

The awarding of this contract will not alter the current workload for staff.

12. COMMUNITY AND STAKEHOLDER ENGAGEMENT

Community Engagement for the new clubrooms and the required changes to the Community Land Management Plan was undertaken in March 2023. Following this, at its meeting on 9 May 2023, Council endorsed changes to the Tilley Recreation Park Community Land Management Plan to allow for the new clubroom building to be constructed.

Council undertook extensive stakeholder workshops and reviews with the TTGCSC during the design phase and the club has endorsed the design.

13. COMMUNICATIONS OF COUNCIL DECISION

TTGSC will be advised of the scheduled commencement of works and given monthly updates as construction progresses.

14. INTERNAL REPORT CONSULTATION

The following staff have been included in the consultation process in the preparation of this Report.


| Name | Position | Consulted about |
|---------------|-------------------|----------------------------|
| Claire Victor | Contracts Officer | Procurement Process |
| Rebecca Bains | Manager Finance & | Financials |
| | Rating Services | |

Attachments

- 1. Tilley Recreation Park Clubroom Design
- 2. Mark up of scope reduction Tilley Recreation Park Clubroom

Report Authorisers

| Erica Vidinis Strategic Project and Stakeholder Manager | 8397 7444 |
|--|-----------|
| Greg Salmon Manager Project Management Office | 8397 7444 |
| Ryan McMahon Chief Executive Officer | 8397 7297 |

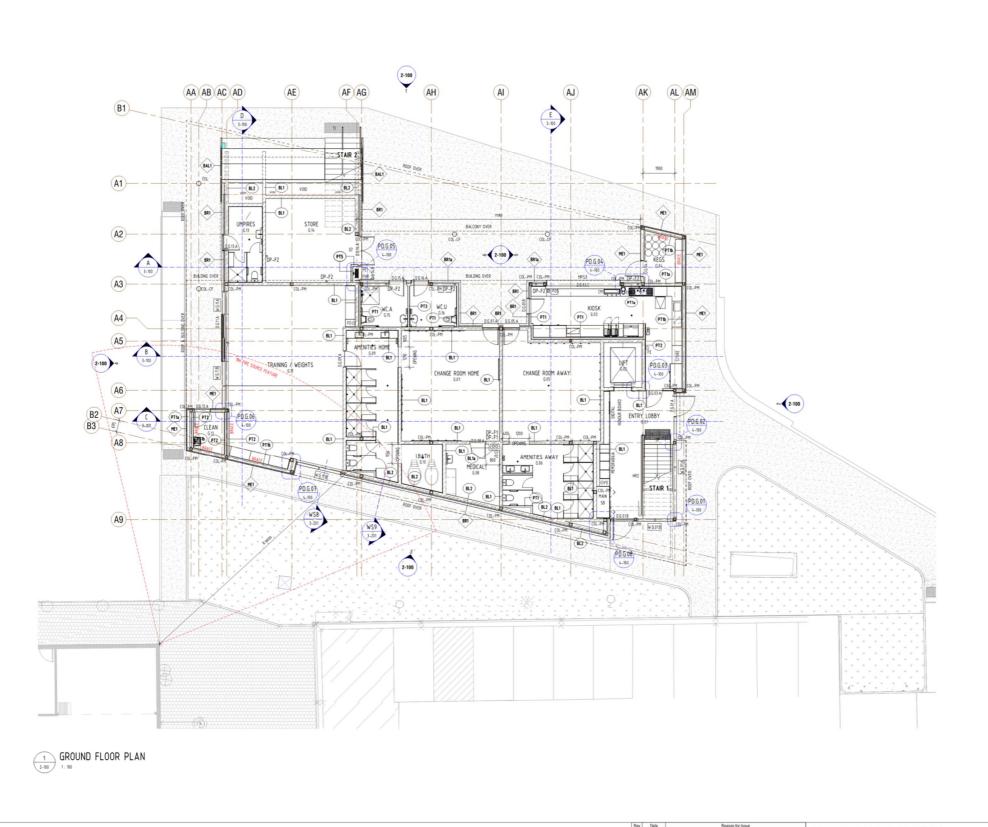



LEGEND - WALLS / PARTITION NOTES

Wall / Portion Types
The internal lines to wall a partition types when adjacent a duct -riser, veid, shalf, carly or fine cabhed.

I layer of ther cement shaeting to be direct sticked to blockwork to the following rooms,
GS APRINTES MAY
GS MCLA
GS WCLA
Fire cement sheeting can be substituted for plasterboard in the following rooms,
ESI 108887
FS STORE
ESI STORE
ESI STORE
ESI STORE
Confirstor to coordinate wall & partition types settud and allow for packing/furring chamed, to external planness to all internal and external lineigs.

Mail Bracing
Provide top of wall stabilisation / bracing to internal walls, typically. Refer to structural expiners details for bracing to internal walls, typically. Refer to structural expiners details for bracing requirements.

| 3000 | DESCRIPTION |
|--------|--|
| COL | Column |
| COL-CF | Column Concrete Filled |
| COL-PM | Column With Promat Board Fire Rated Cladding |
| FE | Fire Extinguisher |
| 1 | |

| C00E | DESCRIPTION | |
|------|--|---|
| BAL1 | custom steel balustrade with glazed infills as detailed | |
| BAL2 | 10mm nom thick steel plate balustrade as detailed | |
| | PARTITION TYPE SCHEDUL | .E |
| 3000 | PARTITION DESCRIPTION | NOTES |
| PT1 | Moisture Barrier as spec./Thermal Insulation as spec. / 92mm wide steel stud framing as spec. / 1 x 9mm flush villaboard (unless otherwise noted) as spec. | To underside of Roof / slab above |
| PTta | Moisture Barrier as spec/Thermal Insulation as spec. / 150nm vide steel stud framing as spec. / 1 x 9nm flush villaboard (unless othervise noted) as spec. | To underside of Roof / slab above |
| PTtb | Mosture Barrier as spec/Thernal Insulation as spec. / 150nn wide steel stud fransing as spec. & 50nn top hat fransing as spec. / 1 x 9nn flush villaboard (unless otherwise noted) as spec. | To underside of Roof / slab above |
| PTZ | 1 x 9mm flush villaboard funiess otherwise noted! as spec.//Coastic Insulation as spec. / 92mm wide steel stud framing as spec. / 1 x 9mm flush willaboard furiess otherwise noted! as spec. | To finish 100mm above cellin level, refer acoustic report for further details. Provide insulation in ceiling in accordance with acoustic engineer's specification. |
| PT3 | 2 x 9mm flush villaboard (unless otherwise noted) as spec/Acoustic Insulation as spec. / 92mm wide steel stud franing as spec. / 1 x 9mm flush villaboard (unless otherwise noted) as spec. | To underside of Roof / slab above, refer acoustic report for further details |
| PTS | 1 x 16mm flush Gyprock Fyrchek Plasterboard funiess otherwise noted) as spec/Acoustic Insulation as spec. / 92mm wide steel stud fra WALLS JAVPE1 SEMEDUALE | To finish 100mm above cellin level, refer acoustic report for further details. Provide |
| 3003 | Opprock Fyrchek Plasterboard funtess all expession asked as spec. | accordance with accordic engineer's specification |
| BL1 | 190mm wide concrete block wall to engineers details / | |
| BL1a | 90mm wide concrete block wall to engineers details / | |
| BL2 | 190mm wide concrete block wall to engineers details / 50mm | n rigid board insulation as sp |
| BR1 | Single leaf 110nm wide brick wall. / 40mm cavity / | |
| BR1a | Single leaf 110nn wide brick wall. / 70nn cavity / | |
| ME1 | 25nm non thick Metal Cladding as spec. / 35nm top hat fro | aning as spec. / |
| TL1 | 20mm tiling as spec. / 175mm precast concrete panels to er | ngineers details, standard gre |

REFER WD-0-002 - PROJECT LEGEND SHEET FOR ALL LEGENDS

ARCHITECTURE - INTERIOR DESIGN LANDSCAPE ARCHITECTURE MASTERPLANNING TILLEY RE
CITY OF TE
HANCOCK
GROUND FL

TILLEY RECREATION PARK CLUBROOM

CITY OF TEA TREE GULLY

HANCOCK RD & YATALA VALE RD, FAIRVIEW PARK SA 5126

GROUND FLOOR PLAN


project no: 22-0436
scale: As indicated @ A1
date: \$105/2023
drawn: MF
sheet no: WD-1-300 revision: 1

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adjo walthrooke .com.au

literarckie.com.au

007 918 514

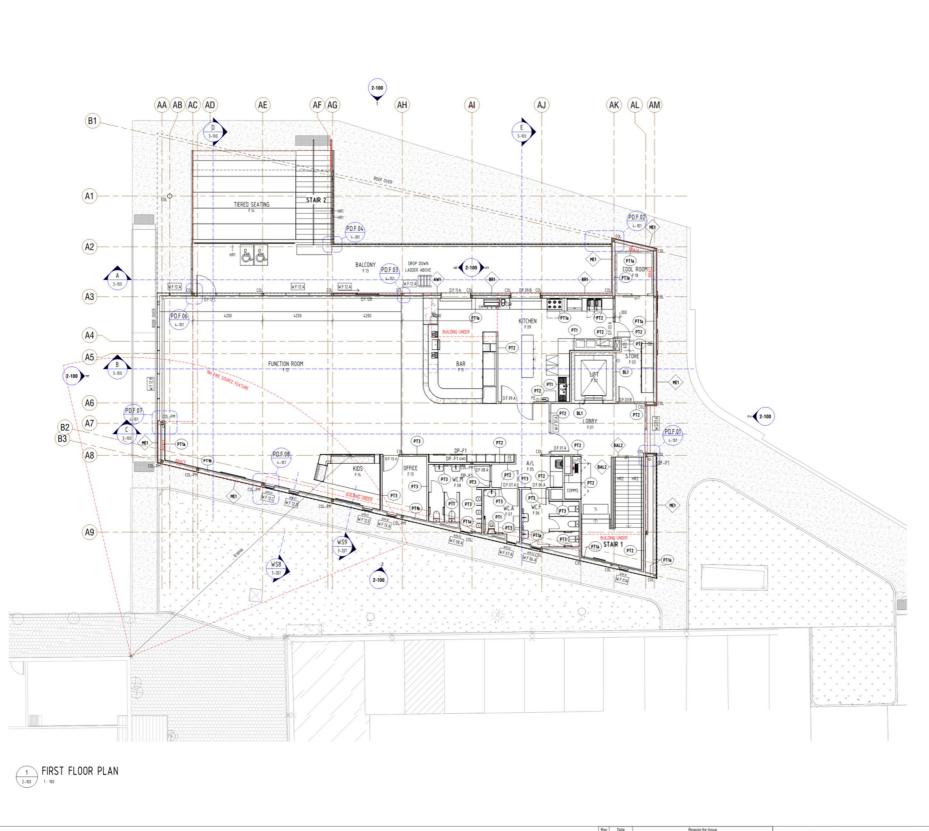

| COL | Column | |
|-------------------------|---|---|
| COL-PM | Column With Promat Board Fire Rated Cladding | |
| FE | Fire Extinguisher | |
| 11 | | |
| | | |
| PARTITION TYPE SCHEDULE | | |
| 3000 | PARTITION DESCRIPTION | NOTES |
| PT1 | Moisture Barrier as spec/Thermal Insulation as spec. / 92nm wide steel stud framing as spec. / 1 x 9nm flush villaboard (unless otherwise noted) as spec. | To underside of Roof / slab above |
| PT1a | Moisture Barrier as spec./Themail Insulation as spec. / 150nn vide steel stud franing as spec. / 1 x 9nn flush villaboard (unless otherwise noted) as spec. | To underside of Roof / slab above |
| PTtb | Moisture Barrier as spec/Thernal Insulation as spec. / 150nn vide steel stud franing as spec. \$ 50nn top hat franing as spec. / 1 x 9nn flush villabsard lunless otherwise noted as spec. | To underside of Roof / slab above |
| PT2 | 1 x 9mn flush villaboard (unless otherwise noted) as spec/Acoustic Insulation as spec. / 92mm wide steel stud framing as spec. / 1 x 9mn flush villaboard (unless otherwise noted) as spec. | To finish 100nn above ceiling level, refer acoustic report for further details. Provide insulation in ceiling in accordance with acoustic engineer's specification. |
| PT3 | 2 x 9mm flush villaboard (unless otherwise noted) as spec/Acoustic Insulation as spec. / 92mm vide steel stud framing as spec. / 1 x 9mm flush villaboard lustless atherwise noted) as spec. | To underside of Roof / slab above, refer acoustic report for further details |
| PTL | 100mm nom wide polyisocyanurate coolroom panel by specialist confractor/ | 2400 high to underside of insulated ceiling. Provide insulation in ceiling a accordance with acoustic engineer's specification. |
| PTS | 1 x 16mm flush Gyprock Fyrchek Plasterboard funless otherwise noted as spec/Acoustic Insulation as spec / Blath wide elem white crus | To finish 100nm above ceiling level, refer acoustic report for further chiletts Provide insulation in ceiling in |
| | framing as spec. / 1 x Ison Flush Gypreck Further Placearchand funless otherwise noted, as | accordance with acoustic engineer's |
| | | |

| 3000 | DESCRIPTION |
|------|---|
| BAL1 | custon steel balustrade with glazed infills as detailed |
| BAL2 | 10mm nom thick steel plate balustrade as detailed |

REFER WD-0-002 - PROJECT LEGEND SHEET FOR ALL LEGENDS

ARCHITECTURE - INTERIOR DESIGN LANDSCAPE ARCHITECTURE MASTERPLANNING

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TILLEY RECREATION PARK CLUBROOM

CITY OF TEA TREE GULLY


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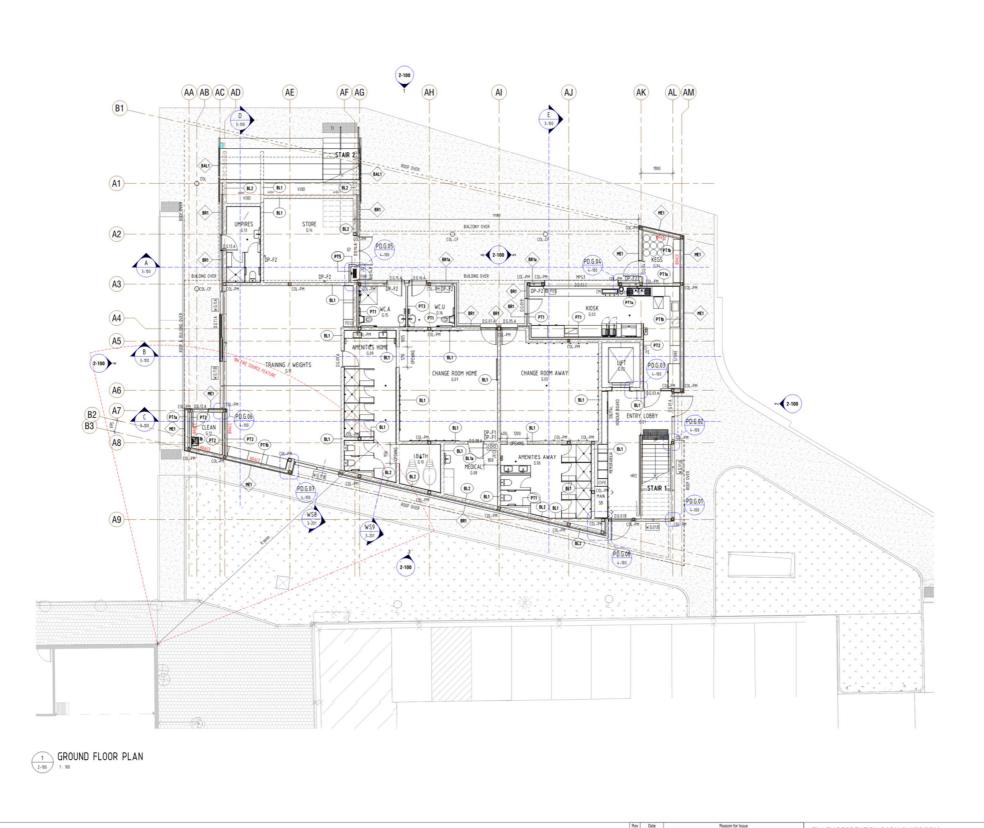
FIRST FLOOR PLAN

project no. 22-0436
scale: As indicated @ A1
date: 5/05/2023
drawn: MF
sheet no: WD-1-301 revision: 1

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| W; | II / Partition Types |
|-----|--|
| No | internal linings to wall & partition types when adjacent a duct riser, void, shaft |
| CS | vity or fire cabinet. |
| 11 | ayer of fibre cement sheeting to be direct sticked to blockwork to the following |
| ro | ons; |
| G. | 6 AMENITES AWAY |
| | 19 AMENITES HOME |
| | 0 BATH |
| | 3 UMPIRES |
| | 5 WCA |
| 6.1 | 6 WCA |
| | are cenent sheeting can be substituted for plasterboard in the following rooms, |
| | 1 L088Y |
| F.O | 3 STORE |
| F.I | 2 FUNCTION ROOM |
| F.1 | 3 OFFICE |
| Со | ntractor to coordinate wall & partition types setout and allow for packing/furring |
| ch | annel, to ensure alignment to all internal and external linings. |
| w | all Bracing |
| Pr | ovide top of wall stabilisation / bracing to internal walls, typically. Refer to |
| sh | ructural engineers details for bracing requirements |

GENERAL ANNOTATIONS SCHEDULE

| LUL | Lolumn | |
|--------|---|---|
| COL-CF | Column Concrete Filled | |
| COL-PM | Column With Promat Board Fire Rated Cladding | |
| FE | Fire Extinguisher | |
| 11 | | |
| | BALUSTRADES (PANELS) TYPE S | CHEDULE |
| CODE | DESCRIPTION | |
| BAL1 | custon steel balustrade with glazed infills as detailed | |
| BAL2 | 10mm nom thick steel plate balustrade as detailed | |
| 3003 | PARTITION DESCRIPTION | NOTES |
| (00E | PARTITION TYPE SCHEDUL PARTITION DESCRIPTION Mosture Barrier as spec./Thernal insulation as spec./ | |
| | 92nm wide steel stud framing as spec. / 1 x 9nm flush villaboard (unless otherwise noted) as spec. | above |
| PTTa | Moisture Barrier as spec/Thermal Insulation as spec. / 150nm wide steel stud framing as spec. / 1 x 9nm flush willaboard (unless otherwise noted) as spec. | To underside of Roof / slab above |
| PTtb | Mosture Barrier as spec./Thermal insulation as spec. / 150nn wide steel stud franing as spec. & 50nn top hat franing as spec. / 1 x 9nn flush villaboard (unless otherwise noted) as spec. | To underside of Roof / slab above |
| PT2 | 1 x 9mm flush villaboard (unless otherwise noted) as spec./Acoustic insulation as spec. / 92mm wide steel stud framing as spec. / 1 x 9mm flush villabsard (unless | To finish 100mm above ceiling level, refer acoustic report for further details. Provide |
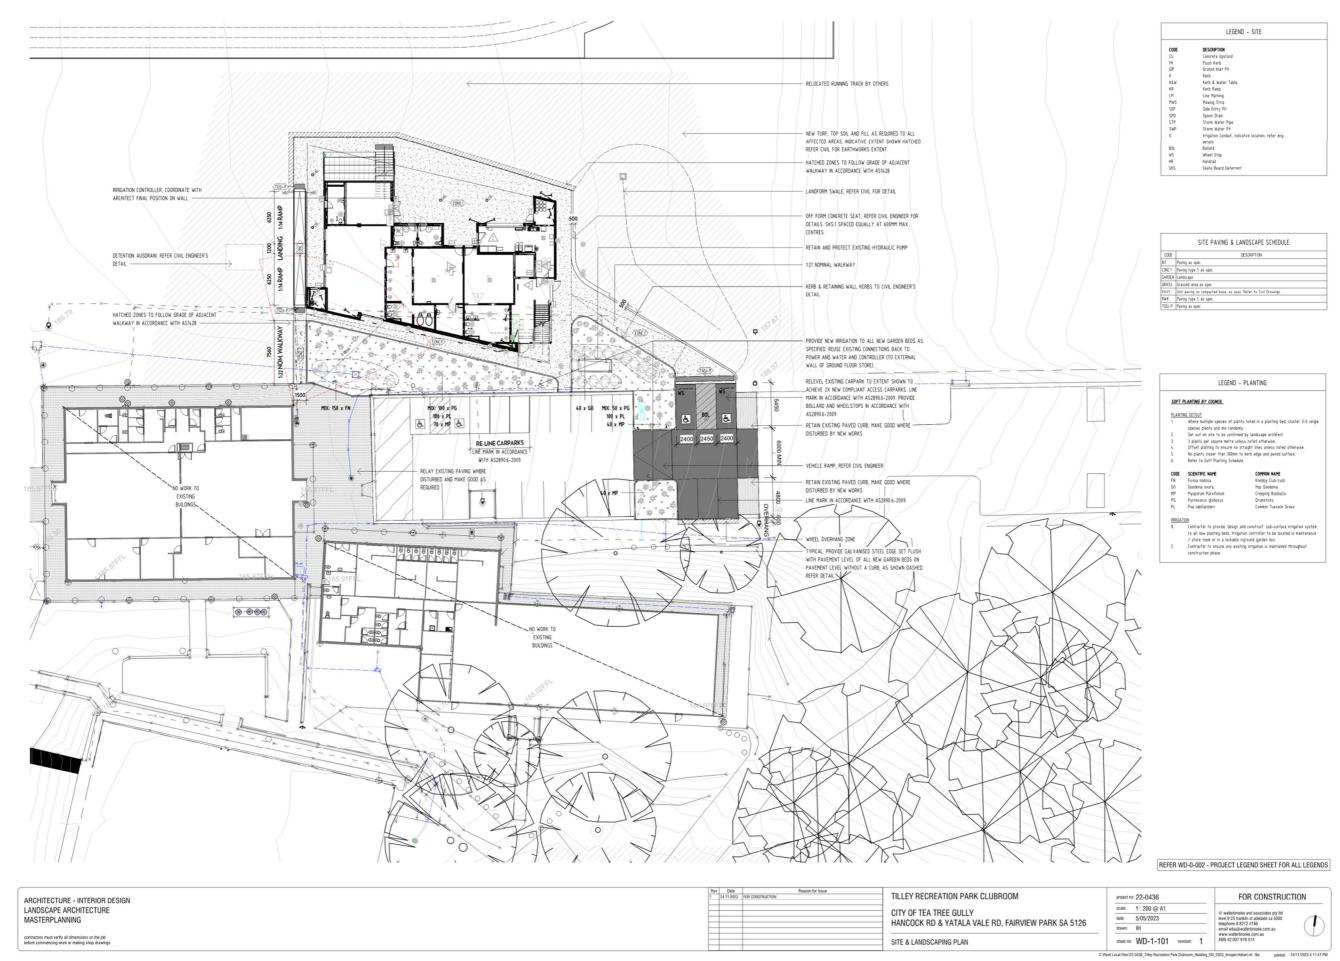
| riq | Toom wide sheel stud framing as spec. If 50mm has hat framing as spec. I some hat framing as spec. I some flush villaboard (unless otherwise noted) as spec. | above |
|------|--|--|
| PT2 | 1 x 9mm flush villaboard funiess otherwise noted as spec.//Ecoastic Insulation as spec. / 92mm wide steel stud framing as spec. / 1 x 9mm flush villaboard furiess otherwise noted as spec. | To finish 100mm above celling level, refer acoustic report for further details. Provide insulation in celling in accordance with acoustic engineer's specification. |
| PT3 | 2 x 9mm flush xillaboard (unless otherwise noted) as spec/Acoustic Insulation as spec. / 92mm wide steel stud framing as spec. / 1 x 9mm flush villaboard (unless otherwise noted) as spec. | To underside of Roof / slab above, refer acoustic report for further details |
| PTS | 1 x 16mm flush Gyprock Fyrchek Plasterboard (unless | To finish 100mm above ceiling |
| | otherwise noted) as spec/Acoustic Insulation as spec. / 92nm wide steel stud fr WALLs SXPE1 SEMEDIULE | level, refer acoustic report for further details. Provide |
| C00E | Opprock Pyrchek Plasterboard funtess all exists nation as spec. | insulation in celling in accordance with accoustic engineer's specification. |
| BL1 | 190nm wide concrete block wall to engineers details / | |
| BL1a | 90mm wide concrete block wall to engineers details / | |
| BL2 | 190mm wide concrete block wall to engineers details / 50mm | n rigid board insulation as spe |

REFER WD-0-002 - PROJECT LEGEND SHEET FOR ALL LEGENDS

ARCHITECTURE - INTERIOR DESIGN LANDSCAPE ARCHITECTURE MASTERPLANNING 1 34 11 2020 FOR CONSTRUCTION TILL
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TILLEY RECREATION PARK CLUBROOM

CITY OF TEA TREE GULLY
HANCOCK RD & YATALA VALE RD, FAIRVIEW PARK SA 5126
GROUND FLOOR PLAN

project no: 22-0436
scale: As indicated @ A1
date: 5/05/2023
drawn: MF
sheet no: WD-1-300 revision: 1

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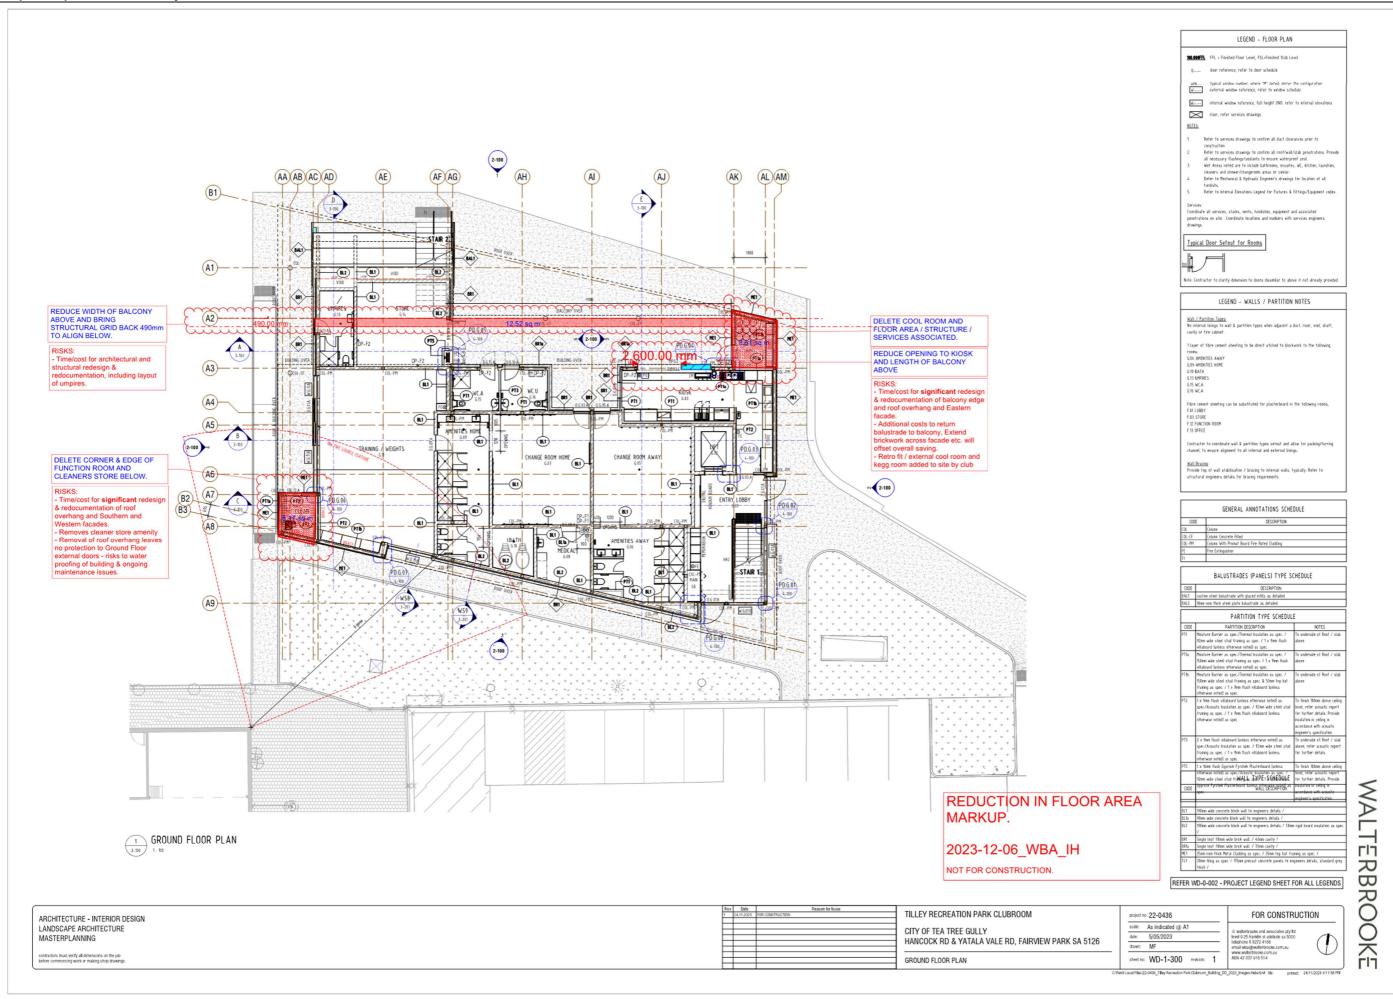
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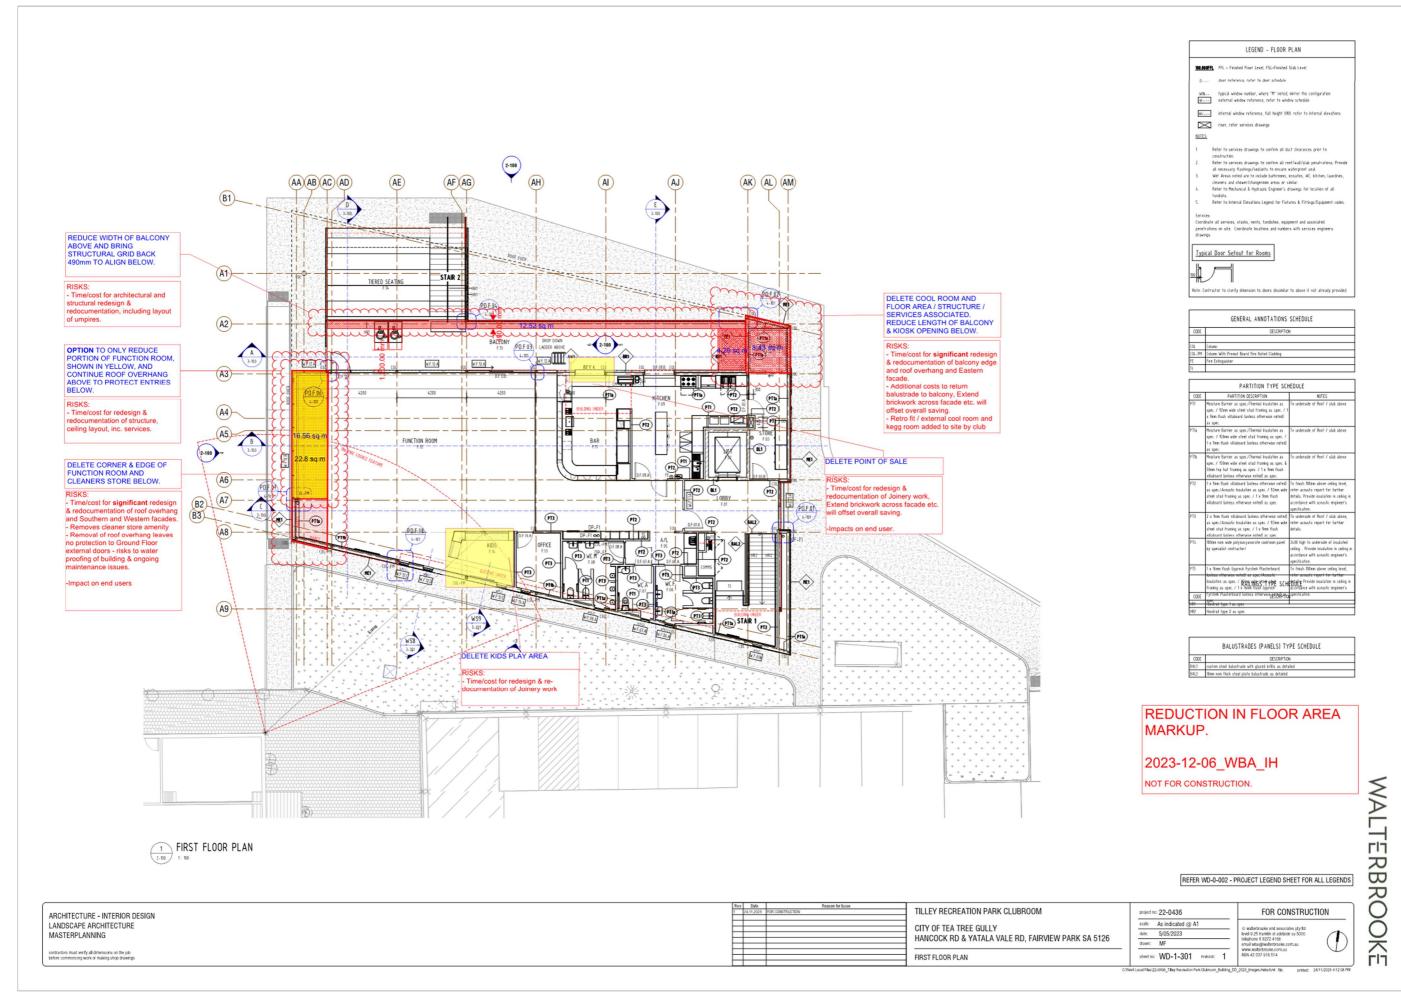
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Mark up of scope reduction - Tilley Recreation Park Clubroom
Attachment 2




Confidential Meeting of Council – 12 December 2023


Mark up of scope reduction - Tilley Recreation Park Clubroom
Attachment 2



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Confidential Meeting of Council – 12 December 2023

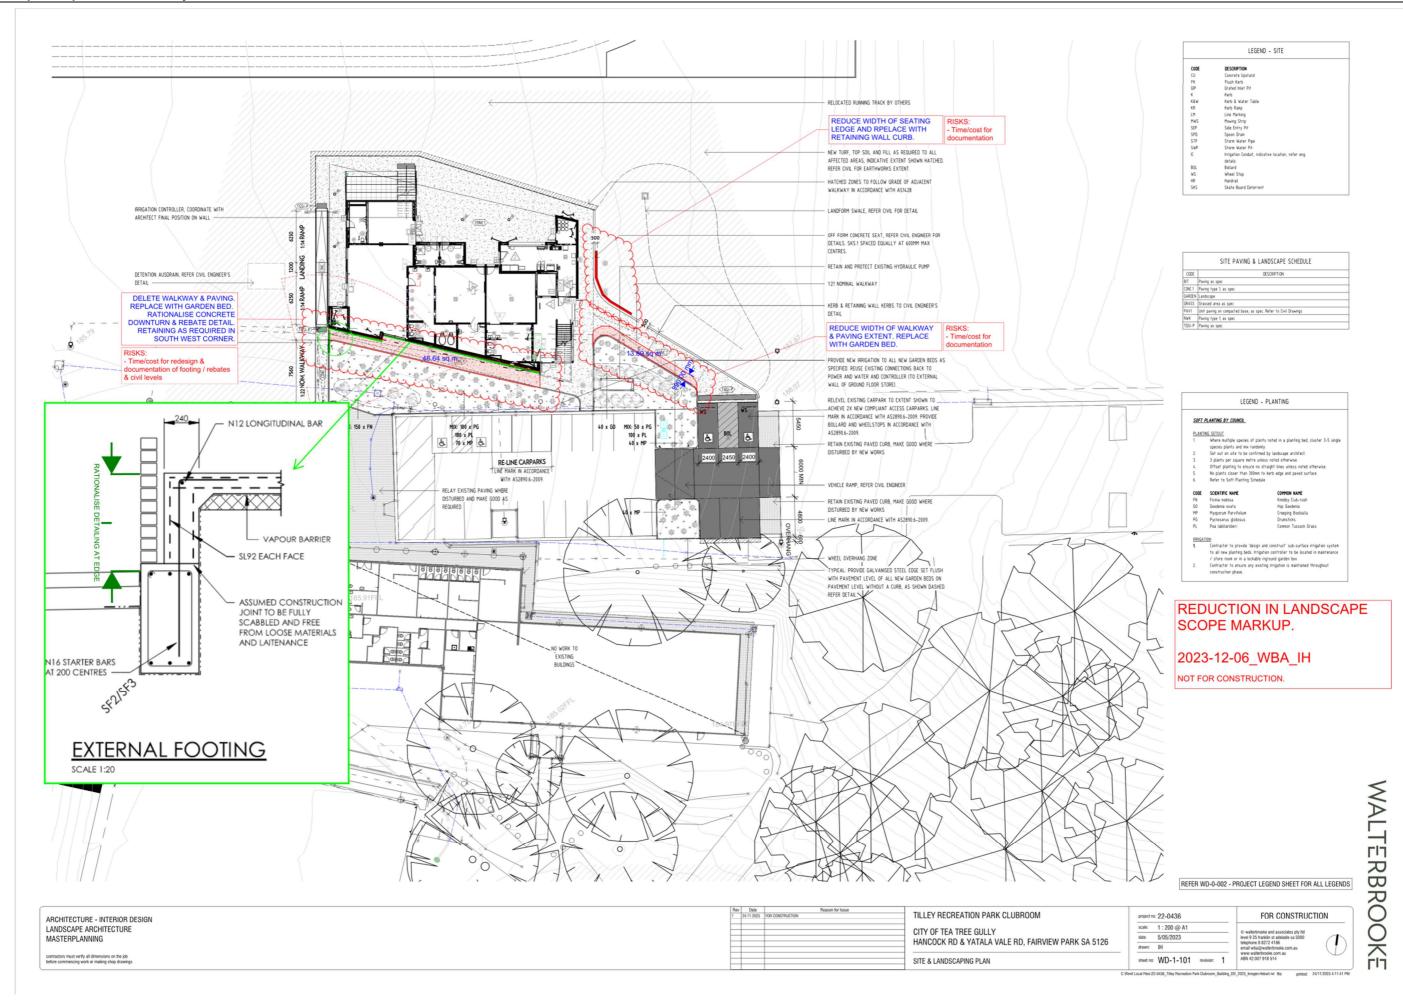

LEGEND - FLOOR PLAN Typical Door Setout for Rooms LEGEND - WALLS / PARTITION NOTES

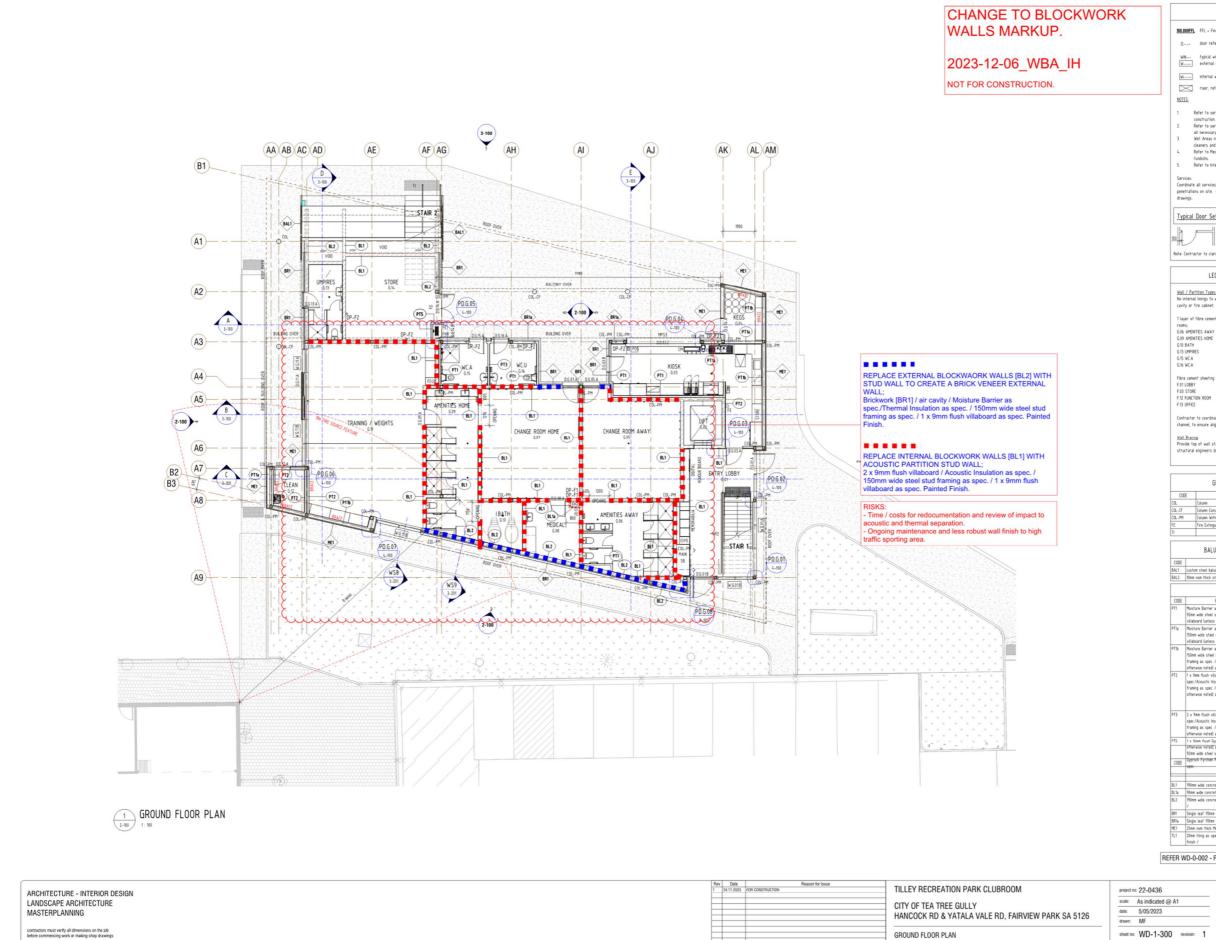Contractor to coordinate wall & partition types setout and allow for pack channel, to ensure alignment to all internal and external linings.

| 3000 | DESCRIPTION | |
|--------|--|--|
| COL | Column | |
| COL-CF | Column Concrete Filled | |
| COL-PM | Column With Promat Board Fire Rated Cladding | |
| FE | Fire Extinguisher | |
| 11 | | |

| E005 | DESCRIPTION | |
|------|--|--|
| BAL1 | custon steel balustrade with glazed infills as detailed | |
| BAL2 | 10mm nom thick steel plate balustrade as detailed | |
| | | |
| | PARTITION TYPE SCHEDUL | E |
| CODE | PARTITION DESCRIPTION | NOTES |
| PT1 | Moisture Barrier as spec./Thermal Insulation as spec. / 92mm wide steel stud framing as spec. / 1 x 9mm flush villaboard (unless otherwise noted) as spec. | To underside of Roof / above |
| Pīta | Moisture Barrier as spec/Thermal Insulation as spec. / 150nn vide steel stud franing as spec. / 1 x 9nn flush villaboard (unless othervise noted) as spec. | To underside of Roof / above |
| PTtb | Mosture Barrier as spec/Thernal insulation as spec. / ISOnn wide steel stud franing as spec. & Sonn top hat franing as spec. / 1 x 9nn flush villaboard (unless otherwise noted) as spec. | To underside of Roof / above |
| PT2 | 1 x 9m flush villaboard funiess otherwise noted as spcc/Acoustic houlation as spec. / 92m wide steel stud framing as spec. / 1 x 9m flush willaboard funiess otherwise noted as spec. | To finish 100mm above level, refer acoustic re for further details. Pro insulation in ceiling in accordance with acoust engineer's specification. |
| PT3 | 2 x 9mm flush villaboard funless otherwise noted) as spec/Acoustic insulation as spec. / 92mm wide steel stud framing as spec. / 1 x 9mm flush villaboard funless otherwise noted) as spec. | To underside of Roof / above, refer acoustic n for further details |
| PTS | 1 x 16mm flush Gyprock Fyrchek Plasterboard luniess otherwise noted) as spec/Acoustic Insulation as spec. / 92mm wide steel stud fr WALLs TXPE I SEMEDULE | To frish 100mm above level, refer acoustic re for further details. Pro |
| C00E | Opprock Fyrchex Plasterboard Juniess all egypto pasters as spec- | insulation in colling in accordance with accord- engineer's specification |
| BL1 | 190mm wide concrete block wall to engineers details / | |
| BL1a | 90mm wide concrete block wall to engineers details / | |
| BL2 | 190nm wide concrete block wall to engineers details / 50nm rigid board insulation at / | |
| 8R1 | Single leaf 110nm wide brick wall. / 40nm cavity / | |
| BR1a | Single leaf 110nn wide brick wall. / 70nn cavity / | |
| ME1 | 25mm nom thick Metal Cladding as spec. / 35mm top hat framing as spec. / | |
| | 20nm hiling as spec. / 175mm precast concrete panels to engineers details, standard | |

REFER WD-0-002 - PROJECT LEGEND SHEET FOR ALL LEGENDS

FOR CONSTRUCTION sheet no: WD-1-300 revision: 1